


PARIS ROAD

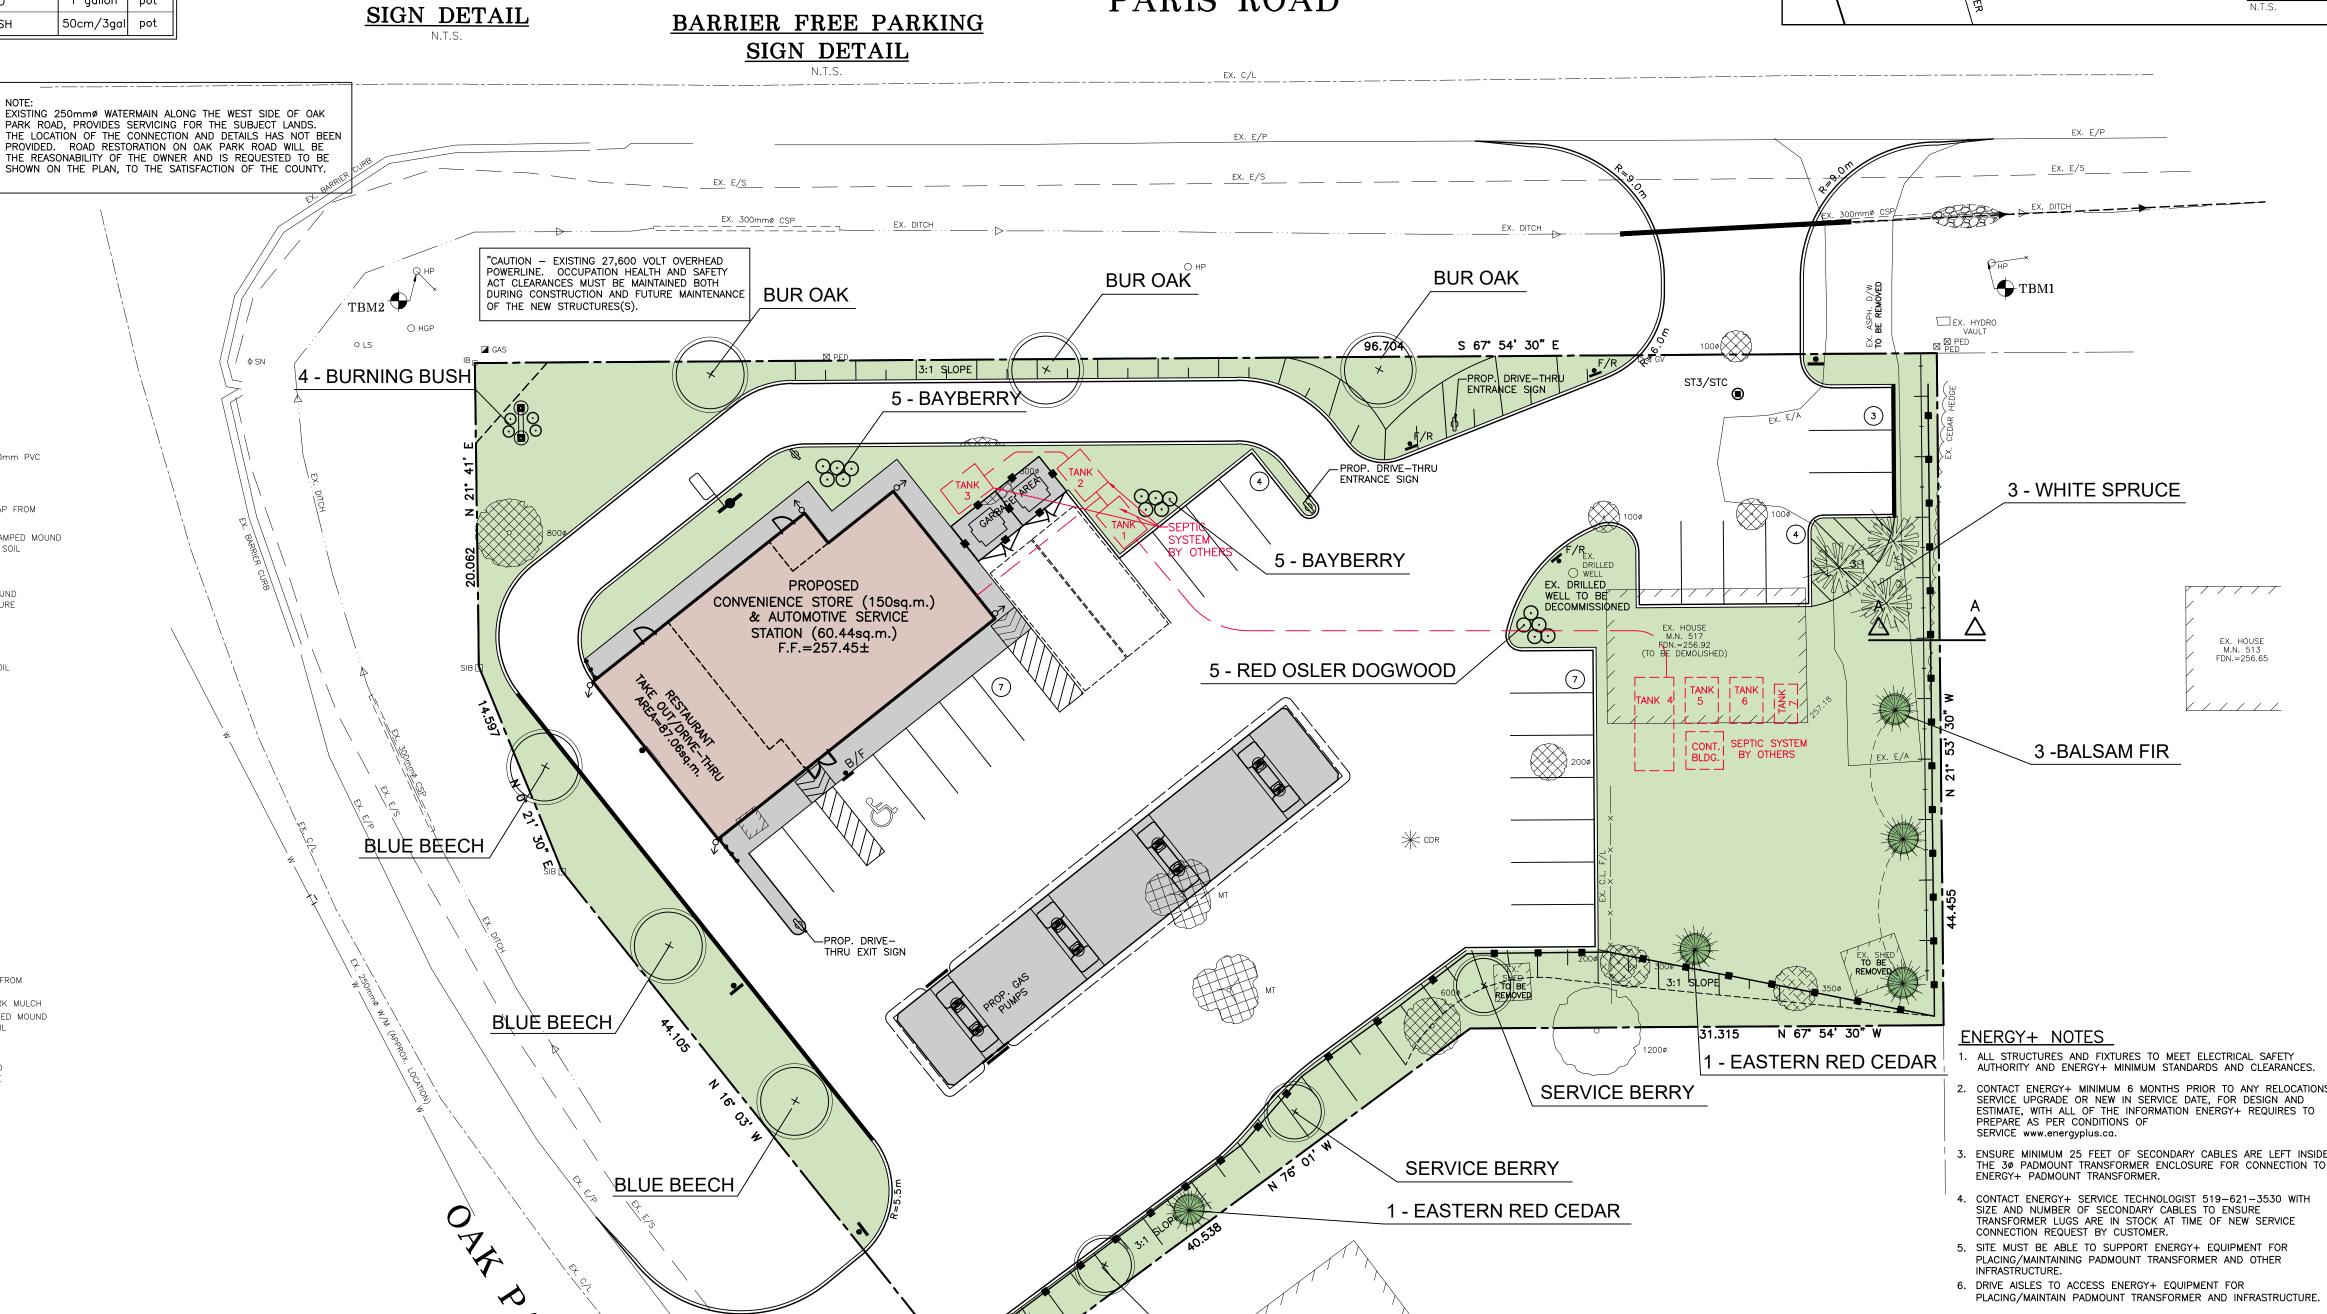

EX. HOUSE M.N. 648 FDN.=258.12

SERVICE BERRY


- EASTERN RED CEDAR


 ALL STRUCTURES AND FIXTURES TO MEET ELECTRICAL SAFETY AUTHORITY AND ENERGY+ MINIMUM STANDARDS AND CLEARANCES. 2. CONTACT ENERGY+ MINIMUM 6 MONTHS PRIOR TO ANY RELOCATIONS,

- 3. ENSURE MINIMUM 25 FEET OF SECONDARY CABLES ARE LEFT INSIDE THE 3Ø PADMOUNT TRANSFORMER ENCLOSURE FOR CONNECTION TO ENERGY+ PADMOUNT TRANSFORMER.
- 4. CONTACT ENERGY+ SERVICE TECHNOLOGIST 519-621-3530 WITH SIZE AND NUMBER OF SECONDARY CABLES TO ENSURE
- 7. ENERGY+ INFRASTRUCTURE SHALL NOT BE PLACED OVER
- UNDERGROUND PARKING AREAS/STRUCTURE. 8. WINDOWS SHALL BE INOPERABLE AND NOT PROTRUDE INTO THE
- REQUIRED CLEARANCE AND METALLIC PARTS OF THE BUILDING SHALL BE EFFECTIVELY GROUNDED.
- 9. ALL SIGNS AND FENCE POSTS MUST BE A MINIMUM 1.0m FROM EDGE OF ENERGY+ UNDERGROUND DUCT BANKS.
- 10. MINIMUM DISTANCE FOR TREES/PLANTINGS SHALL BE AS FOLLOWS;
- -5 TO 6m FROM ENERGY+ TRANSFORMER/SWITCH DOORS AND 2m FROM THE SIDES AND BACK.
 -2m FROM CENTERLINE OF ENERGY+ TRENCHES -2m FROM ENERGY+ METERS. -1m FROM ENERGY+ UNDERGROUND VAULTS.
- -MATURE TREE SPREAD/2+4m, HORZ. TO OVERHEAD POWERLINES. -AROUND TRANSFORMERS - 4m FROM THE DOOR AND 2m AROUND -SNOW STORAGE MUST BE A MIN. OF 4m AWAY FROM ENERGY+ TRANS., SWITCHES, VAULTS, ETC.
 -PARKING LOT LIGHTS MUST BE A MIN. OF 6m, HORZ., FROM EX. OVERHEAD POWER LINES.


THE POSITION OF POLE LINES, CONDUITS, WATERMAINS, SEWERS AND OTHER UNDERGROUND AND ABOVEGROUND UTILITIES AND STRUCTURES ARE NOT NECESSARILY SHOWN ON THE CONTRACT DRAWINGS, AND WHERE SHOWN, THE ACCURACY OF THE POSITION OF SUCH UTILITIES AND STRUCTURES IS NOT GUARANTEED. BEFORE COMMENCING WORK, THE CONTRACTOR SHALL FAMILIARIZE HIMSELF OF THE EXACT LOCATION OF ALL SUCH UTILITIES AND STRUCTURES AND SHALL ASSUME ALL LIABILITY FOR DAMAGE TO THEM.

LEGEND

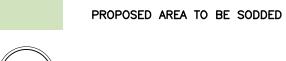

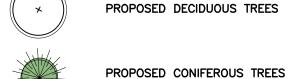

PROPOSED SHRUBS

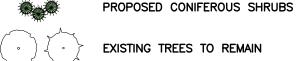

EXISTING TREES TO BE REMOVED

PROPOSED FIRE ROUTE SIGNS

PROPOSED BARRIER FREE PARKING SIGNS PROPOSED STOP SIGNS

LANDSCAPE NOTES:

- 1. BASE INFORMATION OBTAINED FROM 9266-1.DWG SUPPLIED BY J.H. COHOON ENGINEERING LIMITED.
- THE LANDSCAPE CONTRACTOR SHALL VERIFY ALL CONDITIONS IN THE FIELD AND REPORT ANY DISCREPANCIES TO THE LANDSCAPE ARCHITECT PRIOR TO CONSTRUCTION.
- 3. LIMIT OF WORK TO BE THE PROPERTY LINE SHOWN.
- 4. ANY AREAS OUTSIDE THE LIMIT OF WORK DAMAGED BY THE CONTRACTOR SHALL BE RESTORED BY THE CONTRACTOR TO CITY OF BRANTFORD STANDARDS AT NO ADDITIONAL COST TO
- 5. ALL UNDERGROUND UTILITIES TO BE LOCATED BY THE LANDSCAPE CONTRACTOR PRIOR TO THE COMMENCEMENT OF
- 6. ALL DIMENSIONS ARE IN METRES. 7. ALL PLANT MATERIAL TO BE No. 1 GRADE, NURSERY GROWN
- IN ACCORDANCE WITH THE CANADIAN NURSERY TRADES
- 8. PLANT MATERIAL QUANTITIES ON THE DRAWING SHALL TAKE PRECEDENT OVER THOSE IN THE PLANT LIST.
- 9. THE PLANTING PLAN IS TO BE READ IN CONJUNCTION WITH
- THE SITE PLAN (9266-1). 10. ANY PLANT MATERIAL WHICH COMES OVER OR UNDER ANY
- UTILITY WILL BE RELOCATED AS DIRECTED BY THE LANDSCAPE ARCHITECT. 11. SUPPLY & INSTALL A SHREDDED BARK MULCH ON ALL

T.B.M. No. 1 ELEV. = 256.41m

PLANTING BED TO BE A 100mm DEPTH.

NAIL ON SIDE OF HYDRO POLE @ NORTH EAST CORNER OF PROPERTY AS SHOWN.					
NAIL	T.B.M. No. 2 ELEV. = 257.63m (GEO) NAIL ON SIDE OF HYDRO POLE ® NORTH WEST CORNER OF PROPERTY AS SHOWN.				
8	AS PER COUNTY COMMENTS	12/13/21	S.L.M.		
7	AS PER COUNTY COMMENTS	09/29/21	S.L.M.		
6	AS PER COUNTY COMMENTS	04/22/21	S.L.M.		
5	ORIFICE PLATES/PONDING	11/13/18	S.L.M.		
4	SEPTIC SYSTEM BY OTHERS	09/06/17	S.L.M.		
3	REMOVE SIDEWALK @ LOADING	05/29/17	S.L.M.		
2	UPDATE SITE STAT'S	05/12/17	S.L.M.		

TDL STANDARDS

REVISION



J.H. COHOON **ENGINEERING LIMITED**

CONSULTING ENGINEERS

06/28/16 S.L.M.

DATE (MM/DD/YY)

440 HARDY ROAD , UNIT #1 , BRANTFORD - ONTARIO , N3T 5L8 TEL. (519) 753-2656 FAX. (519) 753-4263 www.cohooneng.com


PROPOSED COMMERCIAL DEVELOPMENT PART OF LOT 19, CONCESSION 1

M.N. 517 PARIS ROAD COUNTY OF BRANT

JOHN DANG

LANDSCAPE PLAN

DESIGN:	R.W.P.	SCALE: 1:250	
DRAWN:	S.L.M.	JOB No: 9266	
CHECKED:	R.W.P.		
SHEET:	3 of 3	DWG. No:	
DATE:	MAR. 9, 2017	9266-3	

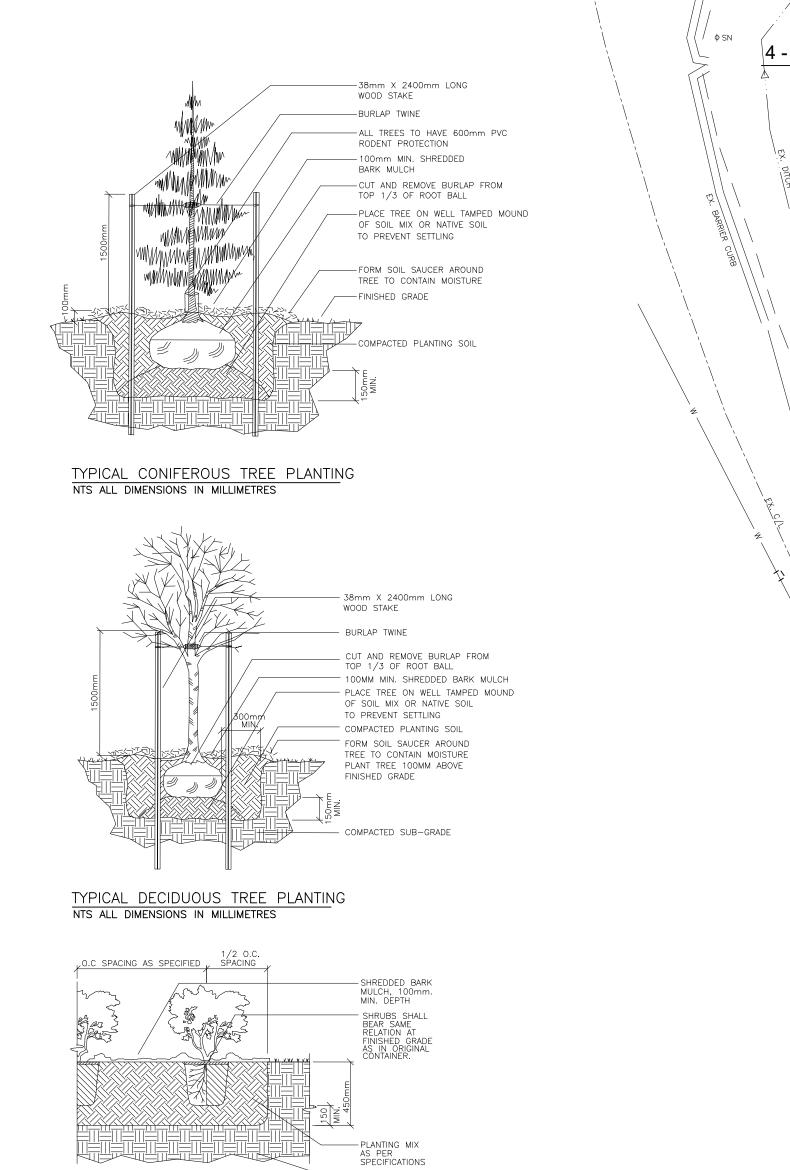

EXCAVATE ENTIRE SHRUB BED AS SHOWN ON DRAWINGS.

EXCAVATE ENTIRE SHRUB BED AS SHOWN ON DRAWINGS. FOR PLANTS IN FIBRE CONTAINERS.
CUT OUT BOTTOM AND SLIT SIDE BEFORE PLANTING.
PLASTIC POT TO BE REMOVED COMPLETELY.
CUT AWAY TOP 1/3 OF BURLAP AND AND ROPE ON B&B
PLANT AND REMOVE WITHOUT DISTURBING ROOT BALL.
PRUNE AS PER STANDARD HORTICULTURAL PRACTICE.
REMOVE RUBBING AND/OR BROKEN BRANCHES,
NURSERY TAGS, PLASTIC OR METAL.
DO NOT TOP PRUNE.

TYPICAL SHRUB PLANTING NTS ALL DIMENSIONS IN MILLIMETRES